

SCALE 1:100 350m<sup>2</sup>

(DP)DATA POINT BUILT 300mm AFL 40A SINGLE PHASE ISOLATOR - AIRCONS 20A SINGLE PHASE ISOLATOR - HAND DRIERS 54A SINGLE ISOLATOR - STOVE PR (projector) **ELECTRICAL NOTES:** CONDUIT LAY-OUT IS DONE BY AND APPROVED Y SPECIALIST, THIS PLAN SHOWS A GRAPHIC DIAGRAM OF THE LAY-OUT FOR APPROVAL PURPOSE ONLY. IS NOT TO BE INTERPRETED LITERALLY FOR LAY-OUT PURPOSES. PLEASE NOTE: PROVISION TO BE MADE FOR LANDSCAPE IRRIGATION AS PER SPECIALIST LATER DESIGN. ALL NECESSARY PROVISION TO BE MADE. ARCHITECTURAL ELECTRICAL LAY-OUT IS A GRAPHICAL REPRESENTATION ONLY OF ELECTRICAL CONDUIT & FITTINGS TO BE PROVIDED WHICH MUST BE APPROVED BY QUALIFIED ELECTRICIAN OR ELECTRICAL ENGINEER CLIENT/OWNER PRIOR TO INSTALLATION. ANY DISCREPANCIES MUST BE REPORTED TO ARCHITECTS PRIOR TO INSTALLATION. ALL LIGHTS TO BE INSTALLED AS PER MANUFACTURER SPECIFICATIONS BY SPECIALIST. ALL LIGHTS AND FITTINGS AS PER CLIENT APPROVAL . ALL ELECTRICAL TO COMPLY WITH NBR & SABS. EXTERNAL LIGHT DESIGN STRATEGY TO BE INCLUDED IN LANDSCAPE PLAN SUBMISSION. ALL ELECTRICAL SUPPLY & CONNECTION TO BE PROVIDED FOR LANDSCAPED IRRIGATION ACCORDING TO LANDSCAPE SPECIALIST DETAILS & SPECIFICATIONS. NO COLOURED LIGHTS ARE ALLOWED. ALL ELECTRICAL WORK TO COMPLY WITH SANS 10400 & INSTALLED BY A QUALIFIED ELECTRICIAN.

LIGHTING LEGEND

rope light (L3)low voltage downlighter

(L4)wall mounted external light fitting (L5) sport light wall mounted fitting

(S2) two way single lever light switch

(S3) tree way single level light switch (S4) four way single level light switch

all light fittings to client's final spec.

IGA SOCKET OUTLET MOUNTED 300mm AFFL UNLESS OTHERWISE STATED (DS)16A DOUBLE SOCKET OUTLET MOUNTED 300n AFFL UNLESS OTHERWISE STATED 16A SOCKET OUTLET MOUNTED 1300mm AFFL UNLESS OTHERWISE STATED (DS)16A DOUBLE SOCKET OUTLET MOUNTED 1300 AFFL UNLESS OTHERWISE STATED

16A WATERPROOF SOCKET OUTLET MOUNTED

MOUNTED ABOVE 100mm ABOVE WHB
T.V. SOCKET OUTLET MOUNTED 300mm BELOW
CEILING LEVEL UNLESS OTHERWISE STATED

DOUBLE POLE ISOLATOR FOR ELECTRIC OVEN MOUNTED AT LIGHT SWITCH HEIGHT

(TP) TELEPHONE POINT

SYMBOL DESCRIPTION


ELECTRICAL POWER LEGEND

SYMBOL FITTING DESCRIPTION DISTRIBUTING BOARD (DB-CH)

NL

# TEL/TV/DATA **GROUND FLOOR PLAN**

AS PER I.T AND COMMUNICATION DOCUMENT 25MM VOICE & DATA CONDUIT 25MM VOICE & DATA CONDUIT 25MM VOICE & DATA CONDUIT MAIN FEED VOICE & DATA CONDUIT 50mm CONDUIT TO BOUNDARY AND FIRST FLOOR.

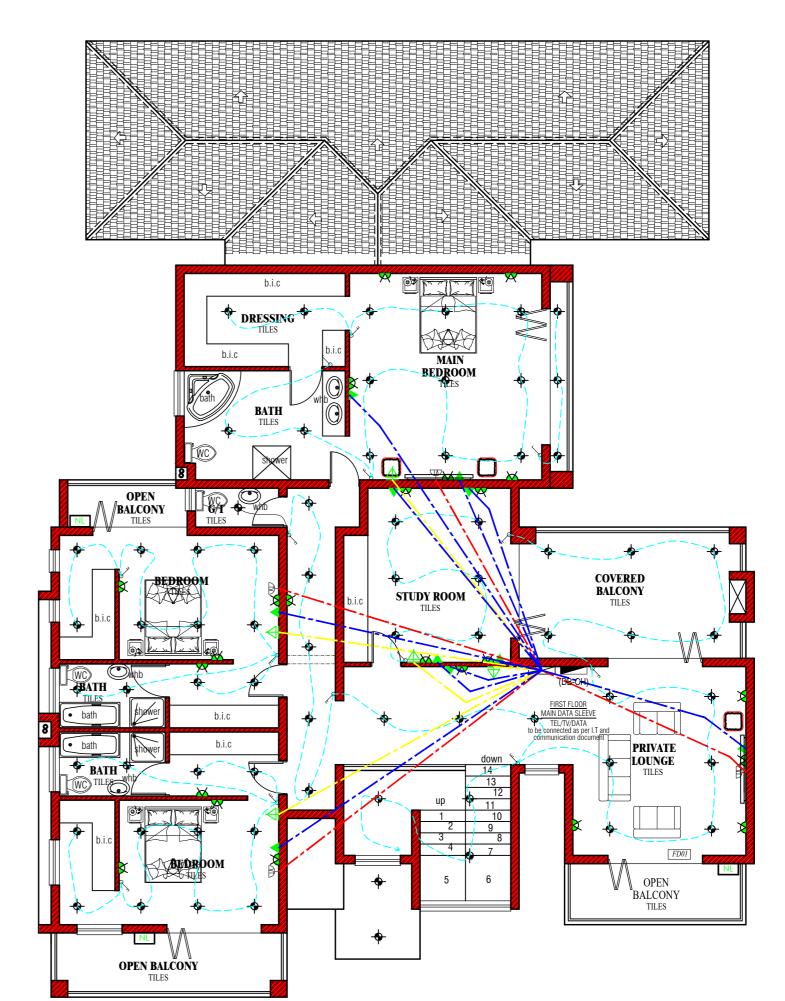

### FIRST FLOOR PLAN

SCALE 1:100 377m<sup>2</sup>

- do not scale drawings. figured dimensions only to be accepted overall dimension to take preference.
   all levels and dimensions to be checked on site before any works are indertaken which is dependant on these sizes.
   consult architect in connection with anything indistinct or obscure these drawings and report any errors, discrepancies or ommissions immediately.

   all works to comply with the national building regulations and local authority requirements.

To be constructed in accordance with Part H of SANS 10400, and strictly to structural engineer's detail & specification. All trenches and concrete to approved standards and checked by the building inspector and structural engineer.

WALLS:

Foundation walling: to Structural Eng detail & spec. All cavities to be filled with concrete surface bed level. All brickwork to be imperial ROKs (110 x 220 x 75). MASONRY

To be constructed in accordance with Part K of SANS 10400 .280 mm cavity masonry walls to Structural Eng detail and spec.

With rock in weld mesh 100X50X2.5 externally and bagged and painted internally. Lintols: Precast R.C. lintols for all openings not exceeding 3000. Lintols to extend min 230mm beyond opening. Min 4 x courses brickwork above with brickforce in each course.

Expansion joints to be provided between existing and new brickwork.

Expansion joints at max 10m of free-standing wall, all in accordance with Structural Endetail & spec.Beam filling to underside of roof sheets

## STRUCTURAL TIMBERS All to be boron treated V4 or better SA pine or gum.

ROOF:
To be constructed in accordance with Part L of SANS 10400 as well as SABS 062

Glazing to doors & windows exceeding 1sqm, or less than 300mm above FFL, to be safety glazing in accordance with Part N SANS 10400. All safety glass to be non-liquid laminate. All panes sizes and thickness as descibed on window schedule Bathrooms windows to be frosted glass

All waste pipes o be min 40mmØ. CEILINGS AND HEADROOM:
All ceillings to conform with part CC3.2 table 2 of SANS 10400 min.2100mm head room at

WORKMANSHIP: All work to local authority building regulations. Workmanship to be of highest standard and comply with all SANS and relevant specified standards for fixing/ finishing.

ENVIRONMENTAL REQUIREMENTS:
- Fenestration area is less than 15% of Nett floor area per storey in accordance with SANS XA 4.4.4
- Roof lighting area is between 1.5% & 10% of Area of served space in accordance with SANS 204:2011

REVISION.		
No.	DATE	DESCRIPTION
Α		
В		

## AREA SCHEDULE

GROUND INCLUDING GARAGE FLOOR AREA	= 350m <sup>2</sup>
FIRST FLOOR PLAN AREA WITHOUT OPEN BALCONY	= 248m <sup>2</sup>
FIRST FLOOR INCLUDING ALL BALCONIES AREA	= 277m <sup>2</sup>
GARAGE AREA	= 80m <sup>2</sup>
TOTAL AREA OF THE HOUSE	= 627m <sup>2</sup>
SITE PLAN AREA	= 816m <sup>2</sup>
SITE COVERAGE	= 42.9%

FIRST FLOOR PLAN COVERS 70% OF THE GROUND FLOOR



GVM HOUSE, PLEIN STREET WEST KAREN PARK

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CLIENT: NDLOVU L.O

project:

PROPOSED NEW HOUSE ON **ERF 168 XANADU ECO PARK** 

drawing title

DRAWING TYPE: COUNCIL APPROVAL Scale As Shown | Client Signature Designed Drawn Checked Arch Signature M.E.M N.A M.E.M Reg Number Pr Engineer Reg Number

PROJECT NO: DRAWING NO: